



SITE PLAN
SCALE 1"=30'

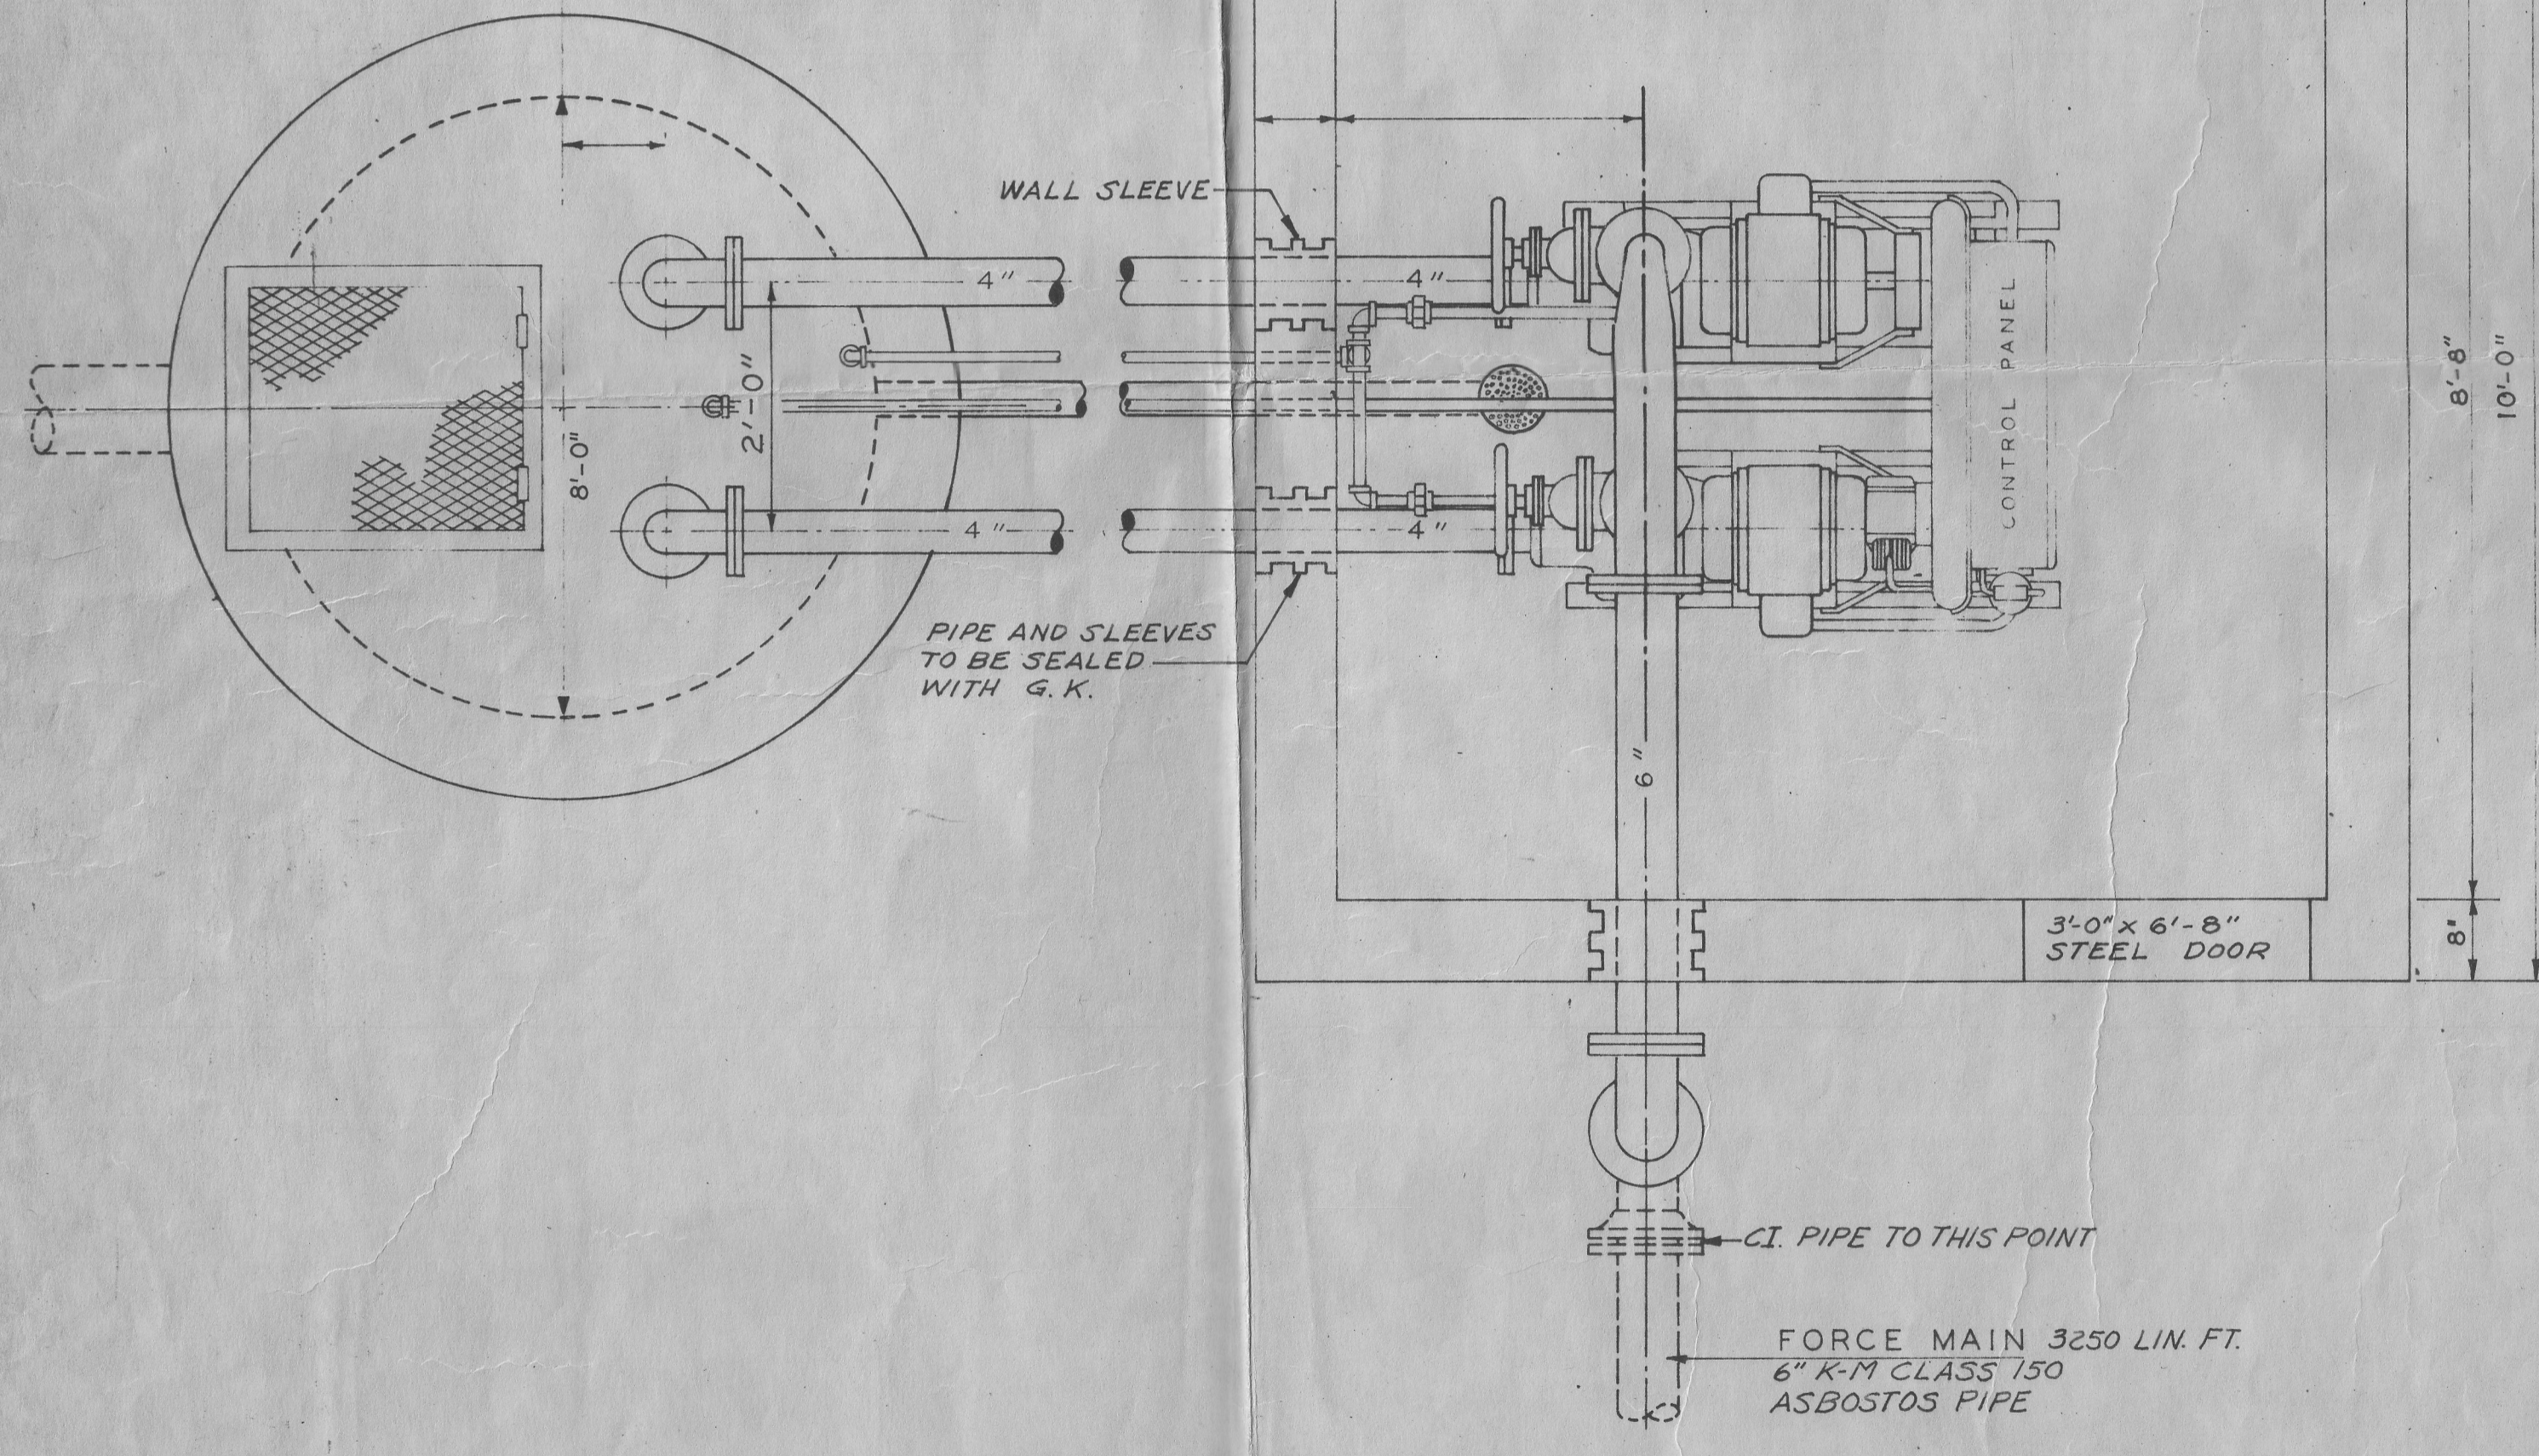

PLAN

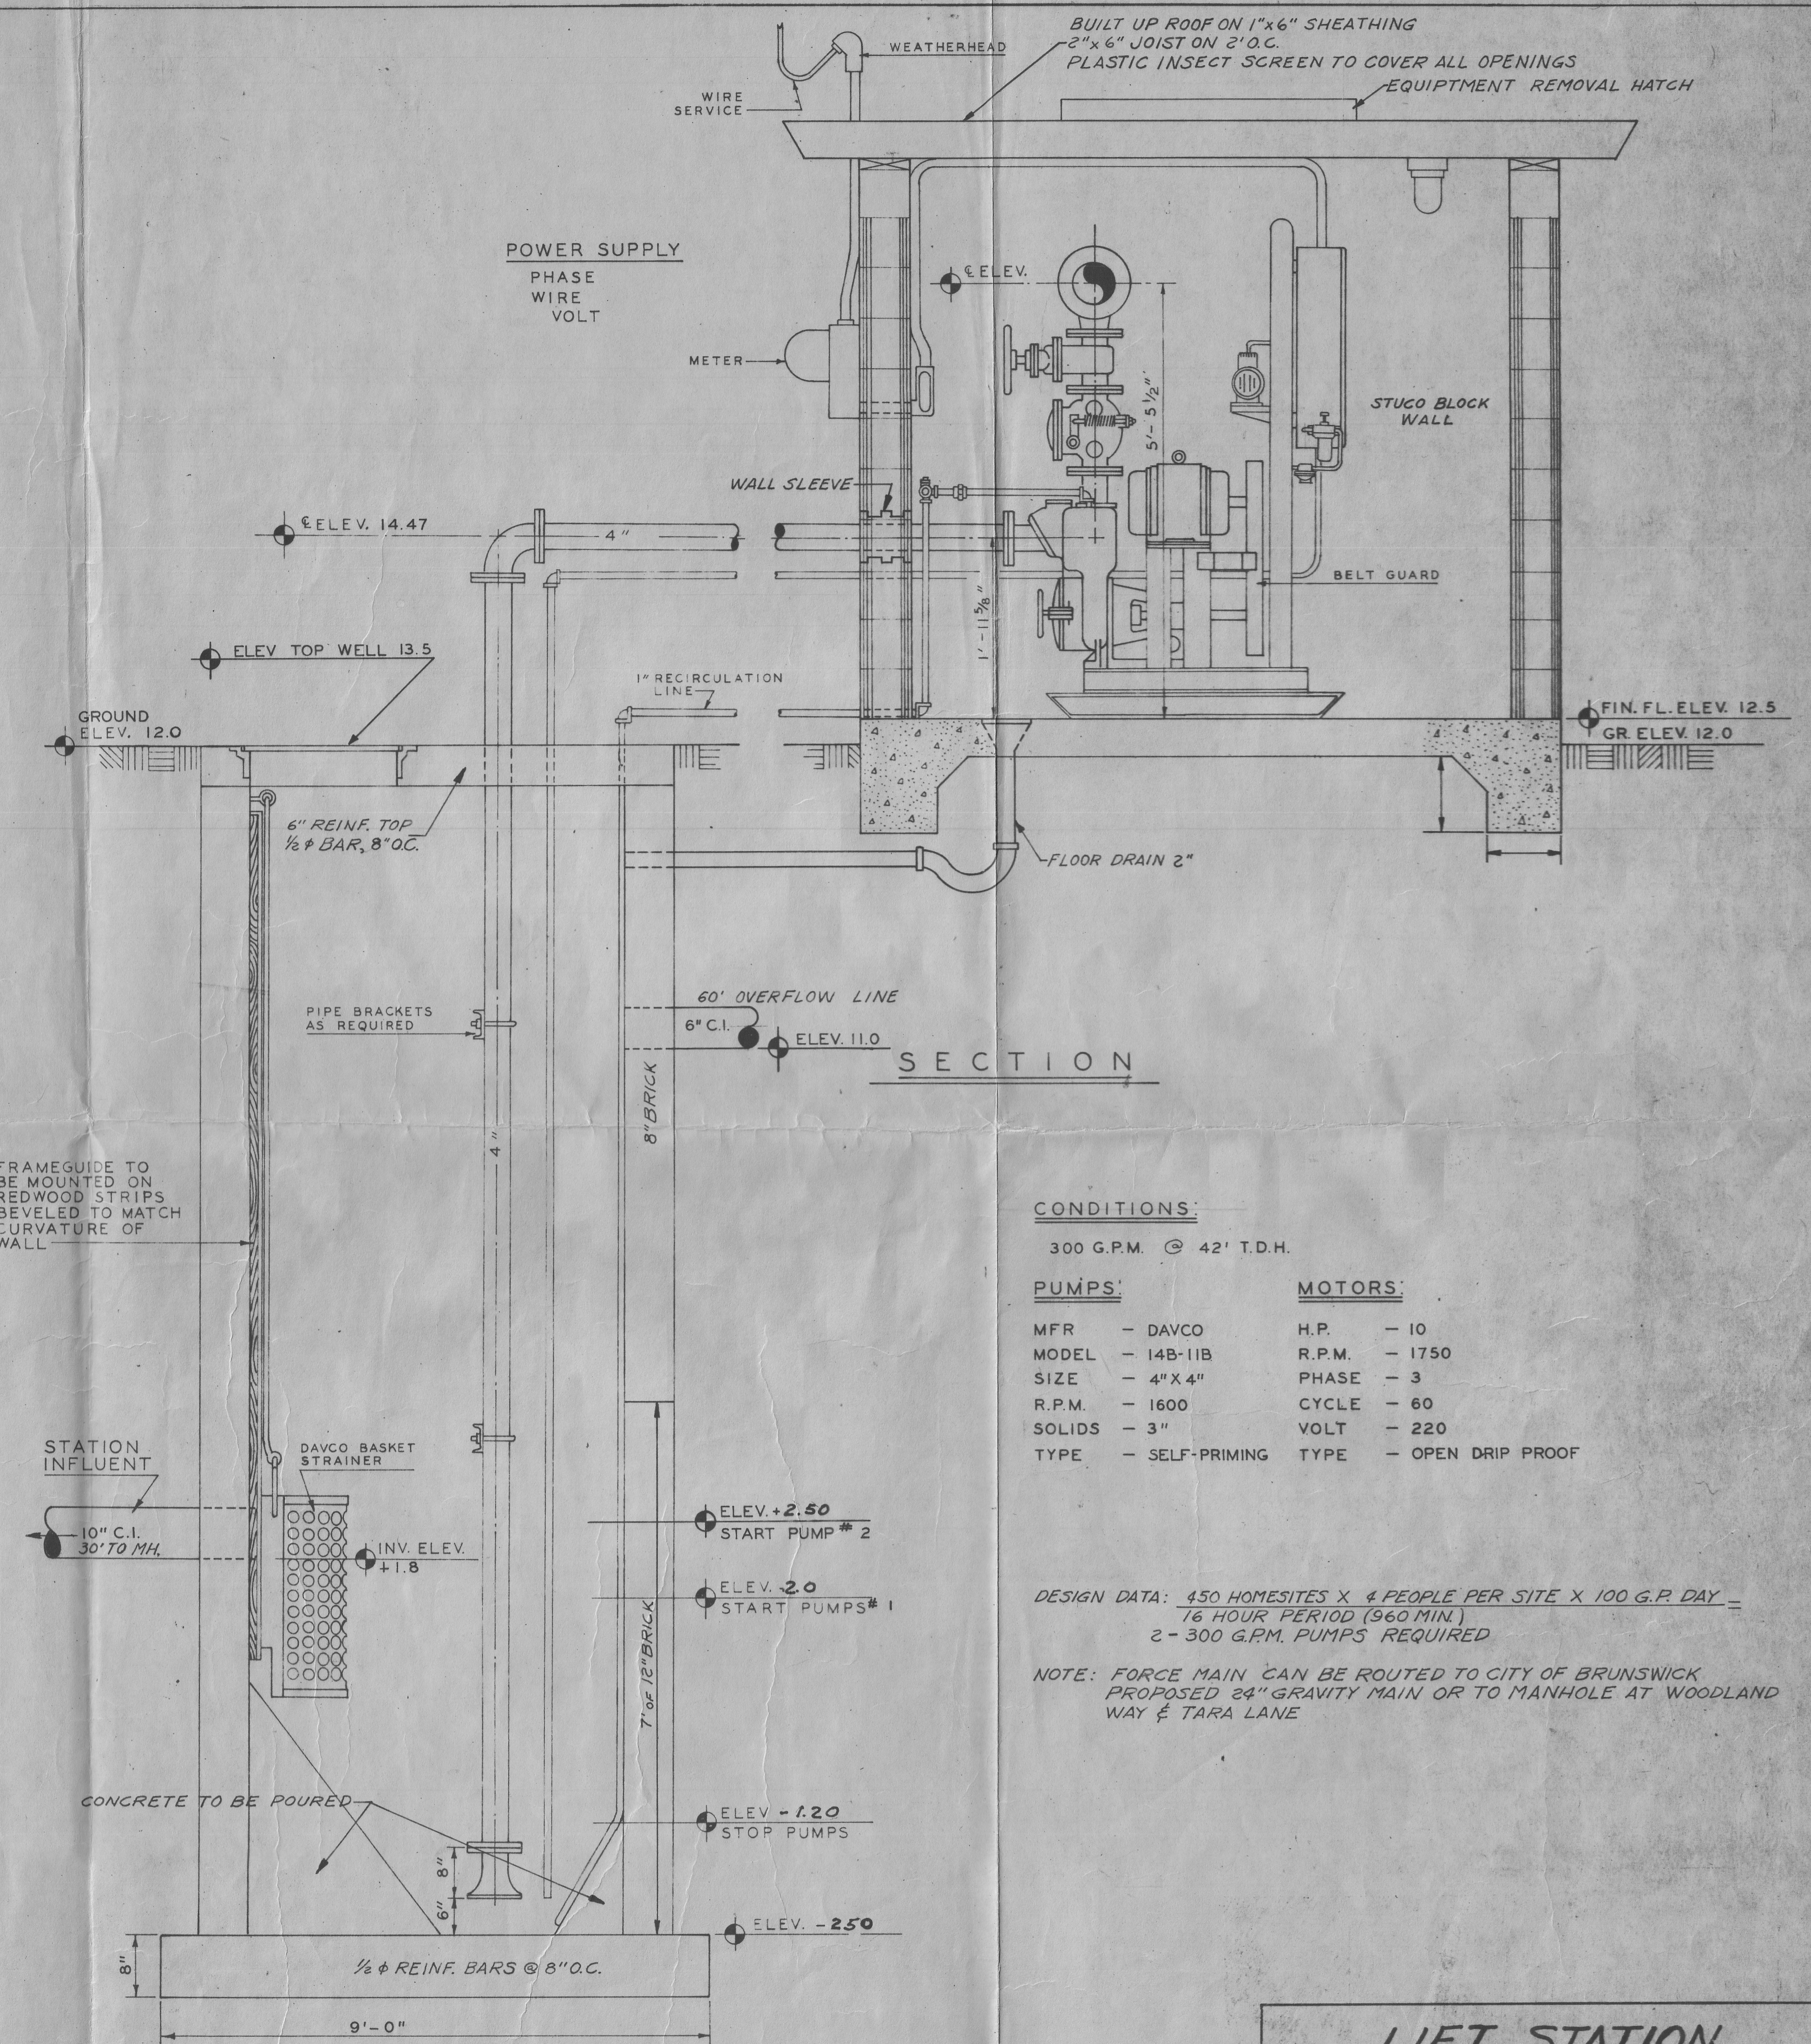

SECTION

CONDITIONS:

300 G.P.M. @ 42' T.D.H.

PUMPS:

MFR - DAVCO
MODEL - 14B-11B
SIZE - 4" X 4"
R.P.M. - 1600
SOLIDS - 3"
TYPE - SELF-PRIMING

MOTORS:

H.P. - 10
R.P.M. - 1750
PHASE - 3
CYCLE - 60
VOLT - 220
TYPE - OPEN DRIP PROOF

DESIGN DATA: 450 HOMESITES X 4 PEOPLE PER SITE X 100 G.P. DAY =
16 HOUR PERIOD (960 MIN.)
2 - 300 G.P.M. PUMPS REQUIRED

NOTE: FORCE MAIN CAN BE ROUTED TO CITY OF BRUNSWICK
PROPOSED 24" GRAVITY MAIN OR TO MANHOLE AT WOODLAND
WAY & TARA LANE

LIFT STATION
MAGNOLIA PARK

DATE: APRIL 2, 1962
SCALE: AS SHOWN
DRAWN BY: W.B.R.
DESIGNED BY: J.H.R.

DELTA ENGINEERS
104 SHANGRI-LA AVE.
BRUNSWICK, GEORGIA